DOUGLAS UNIFIED SCHOOL DISTRICT

WEATHERIZATION ROOFING AND STRUCTURAL REPAIRS FARAS ELEMENTARY SCHOOL 410 W FIR AVE, PIRTLEVILLE, AZ 85626

2021







PROJECT SCOPE:

THE PROJECT INVOLVES TWO CAMPUS BUILDINGS AND INCLUDES:

STRUCTURAL STABILIZATION OF PORTIONS OF THE BUILDING FOUNDATIONS, LEVELING

THE WORK WILL TAKE PLACE DURING THE SCHOOL YEAR

SFB CONTACT: **DEBORA NORRIS**

DNORRIS@AZSFB.GOV

ARCHITECT:


ROBERT POLCAR ARCHITECTS (602) 317-7209 KIRBY@RPARCHITECTS.COM


STRUCTURAL

RYAN WENDT BRODERICK ENGINEERING RYAN@BRODERICKENG.COM ENGINEER:

SCHOOL CONTACT: FERNANDO QUINONEZ FQUINONEZ@DUSD.K12.AZ.US

SFB PROJECT #: 020227105-9999-012-BRG

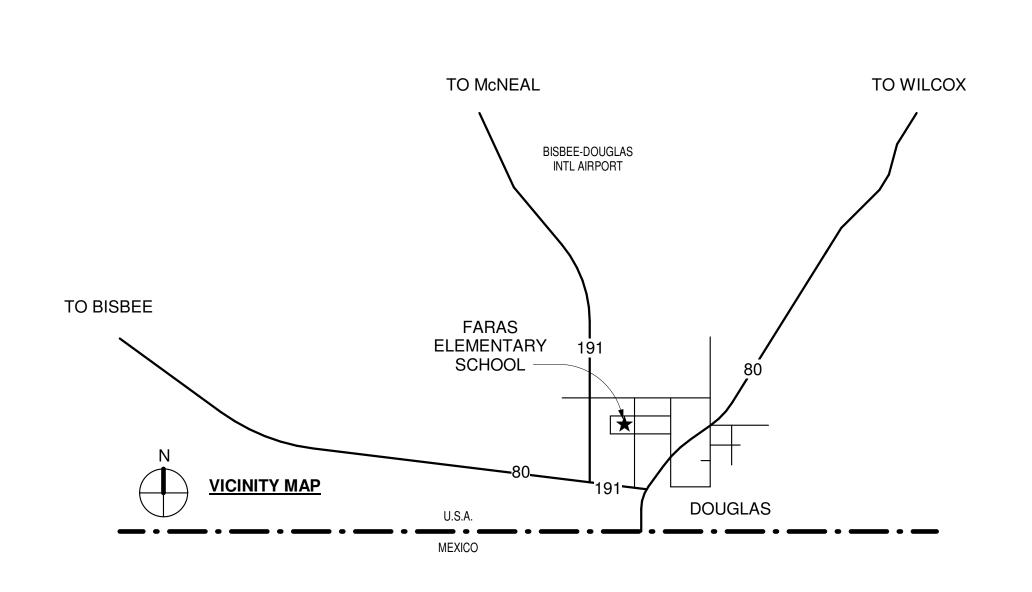

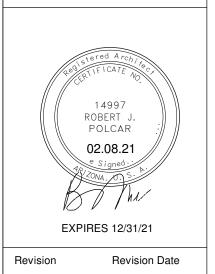


Project number 020227105-9999-012BRG 02.08.21

Drawn by Checked by

COVER SHEET

Sheet Size

ARCH D

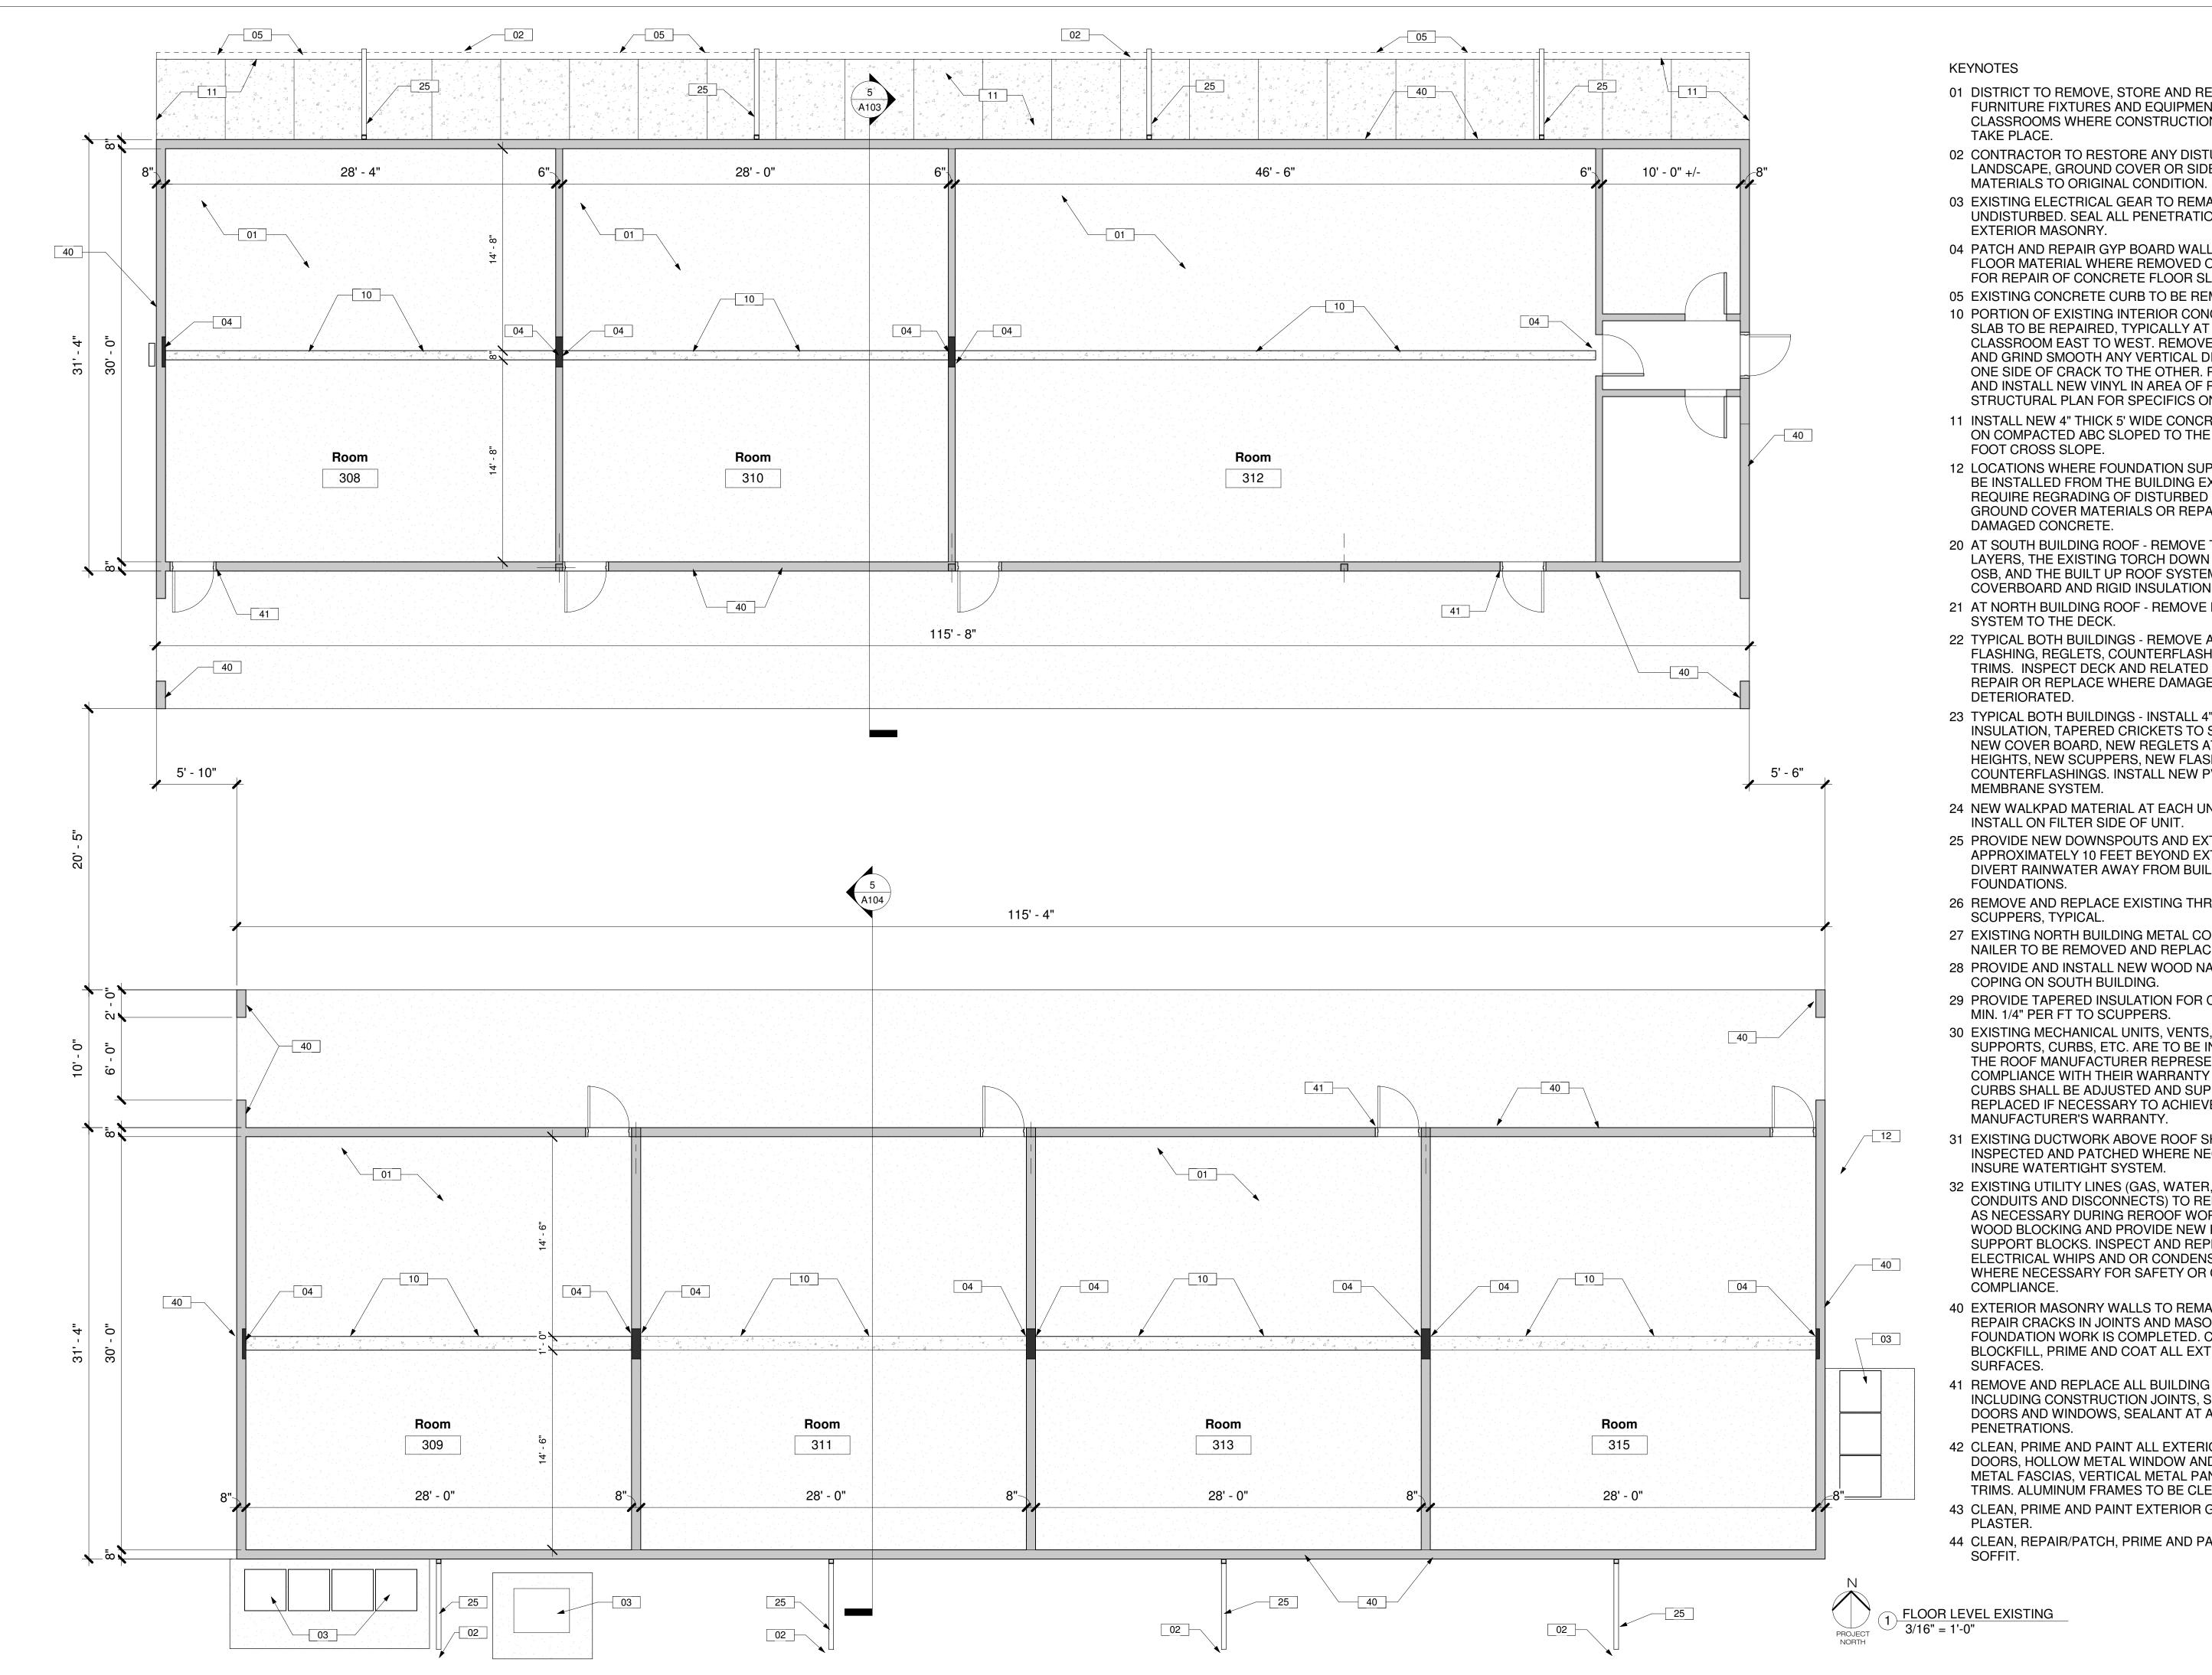

- 01 DISTRICT TO REMOVE, STORE AND REINSTALL FURNITURE FIXTURES AND EQUIPMENT WITHIN CLASSROOMS WHERE CONSTRUCTION WORK IS TO
- 02 CONTRACTOR TO RESTORE ANY DISTURBED LANDSCAPE, GROUND COVER OR SIDEWALK
- 03 EXISTING ELECTRICAL GEAR TO REMAIN UNDISTURBED. SEAL ALL PENETRATIONS THROUGH EXTERIOR MASONRY.
- 04 PATCH AND REPAIR GYP BOARD WALL, BASE AND FLOOR MATERIAL WHERE REMOVED OR DISTURBED FOR REPAIR OF CONCRETE FLOOR SLAB.
- 05 EXISTING CONCRETE CURB TO BE REMOVED.
- 10 PORTION OF EXISTING INTERIOR CONCRETE FLOOR SLAB TO BE REPAIRED, TYPICALLY AT CENTER OF CLASSROOM EAST TO WEST. REMOVE FLOOR TILE AND GRIND SMOOTH ANY VERTICAL DISPLACEMENT ONE SIDE OF CRACK TO THE OTHER. PATCH CRACK AND INSTALL NEW VINYL IN AREA OF REPAIRS. SEE STRUCTURAL PLAN FOR SPECIFICS ON SLAB.
- 11 INSTALL NEW 4" THICK 5' WIDE CONCRETE SIDEWALK ON COMPACTED ABC SLOPED TO THE NORTH 1/4" PER FOOT CROSS SLOPE.
- 12 LOCATIONS WHERE FOUNDATION SUPPORTS ARE TO BE INSTALLED FROM THE BUILDING EXTERIOR REQUIRE REGRADING OF DISTURBED EARTH OR GROUND COVER MATERIALS OR REPAIRING OF DAMAGED CONCRETE.
- 20 AT SOUTH BUILDING ROOF REMOVE TWO ROOF LAYERS. THE EXISTING TORCH DOWN LAYER OVER OSB, AND THE BUILT UP ROOF SYSTEM INCLUDING COVERBOARD AND RIGID INSULATION TO ROOF DECK.
- 21 AT NORTH BUILDING ROOF REMOVE BUILT UP ROOF SYSTEM TO THE DECK.
- 22 TYPICAL BOTH BUILDINGS REMOVE ALL BASE FLASHING, REGLETS, COUNTERFLASHINGS AND EDGE TRIMS. INSPECT DECK AND RELATED ITEMS AND REPAIR OR REPLACE WHERE DAMAGED OR
- 23 TYPICAL BOTH BUILDINGS INSTALL 4" OF NEW RIGID INSULATION, TAPERED CRICKETS TO SCUPPERS, WITH NEW COVER BOARD, NEW REGLETS AT ADJUSTED HEIGHTS, NEW SCUPPERS, NEW FLASHINGS AND COUNTERFLASHINGS. INSTALL NEW PVC ROOF MEMBRANE SYSTEM.
- 24 NEW WALKPAD MATERIAL AT EACH UNIT, TYPICAL. INSTALL ON FILTER SIDE OF UNIT.
- 25 PROVIDE NEW DOWNSPOUTS AND EXTEND APPROXIMATELY 10 FEET BEYOND EXTERIOR WALL TO DIVERT RAINWATER AWAY FROM BUILDING
- 26 REMOVE AND REPLACE EXISTING THROUGH WALL
- 27 EXISTING NORTH BUILDING METAL COPING AND WOOD NAILER TO BE REMOVED AND REPLACED WITH NEW.
- 28 PROVIDE AND INSTALL NEW WOOD NAILER AND METAL COPING ON SOUTH BUILDING.
- 29 PROVIDE TAPERED INSULATION FOR CRICKET, SLOPE MIN. 1/4" PER FT TO SCUPPERS.
- 30 EXISTING MECHANICAL UNITS, VENTS, EXHAUST FANS, SUPPORTS, CURBS, ETC. ARE TO BE INSPECTED BY THE ROOF MANUFACTURER REPRESENTATIVE FOR COMPLIANCE WITH THEIR WARRANTY REQUIREMENTS. CURBS SHALL BE ADJUSTED AND SUPPORTS REPLACED IF NECESSARY TO ACHIEVE THE 20 YEAR MANUFACTURER'S WARRANTY.
- 31 EXISTING DUCTWORK ABOVE ROOF SHALL BE INSPECTED AND PATCHED WHERE NECESSARY TO INSURE WATERTIGHT SYSTEM.
- 32 EXISTING UTILITY LINES (GAS, WATER, OR ELEC CONDUITS AND DISCONNECTS) TO REMAIN, SUPPORT AS NECESSARY DURING REROOF WORK, REMOVE WOOD BLOCKING AND PROVIDE NEW RUBBER SUPPORT BLOCKS. INSPECT AND REPLACE **ELECTRICAL WHIPS AND OR CONDENSATE LINES** WHERE NECESSARY FOR SAFETY OR CODE
- 40 EXTERIOR MASONRY WALLS TO REMAIN, TYPICAL. REPAIR CRACKS IN JOINTS AND MASONRY AFTER FOUNDATION WORK IS COMPLETED. CLEAN, BLOCKFILL, PRIME AND COAT ALL EXTERIOR BLOCK
- 41 REMOVE AND REPLACE ALL BUILDING SEALANTS INCLUDING CONSTRUCTION JOINTS, SEALANT AROUND DOORS AND WINDOWS, SEALANT AT ALL BUILDING PENETRATIONS.
- 42 CLEAN, PRIME AND PAINT ALL EXTERIOR METAL DOORS, HOLLOW METAL WINDOW AND DOOR FRAMES, METAL FASCIAS, VERTICAL METAL PANELS AND METAL TRIMS. ALUMINUM FRAMES TO BE CLEANED.
- 43 CLEAN, PRIME AND PAINT EXTERIOR GYP BD OR
- 44 CLEAN, REPAIR/PATCH, PRIME AND PAINT EXTERIOR

ROBERT POLCAR ARCHITECTS, INC (480) 675-9760 (602) 363-4096 SCOTTSDALE, ARIZONA

> DISTRICT FHERIZATION /ILLE, AZ 85626 DC FARA 410 W F



Revision Date

Project number


020227105-9999-012BRG

02.08.21 Drawn by

Checked by


Sheet Size ARCH D

FLOOR PLANS

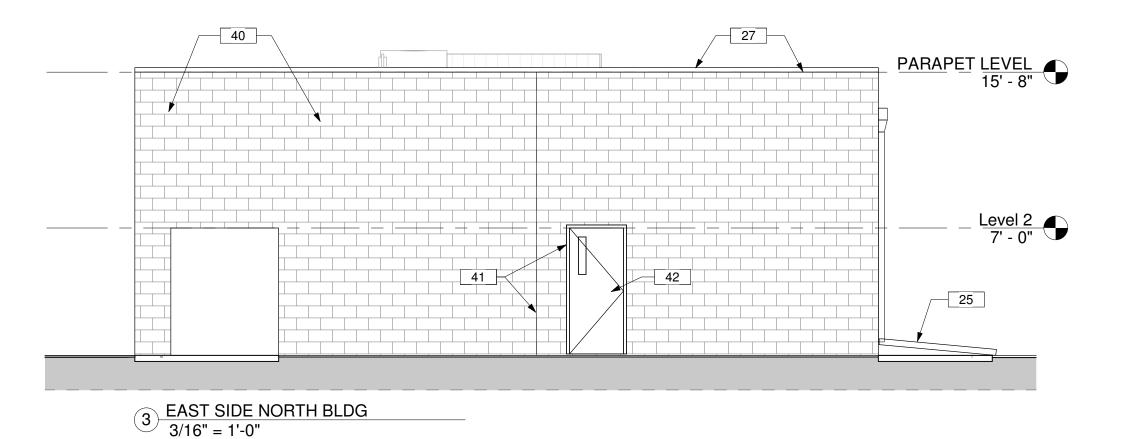







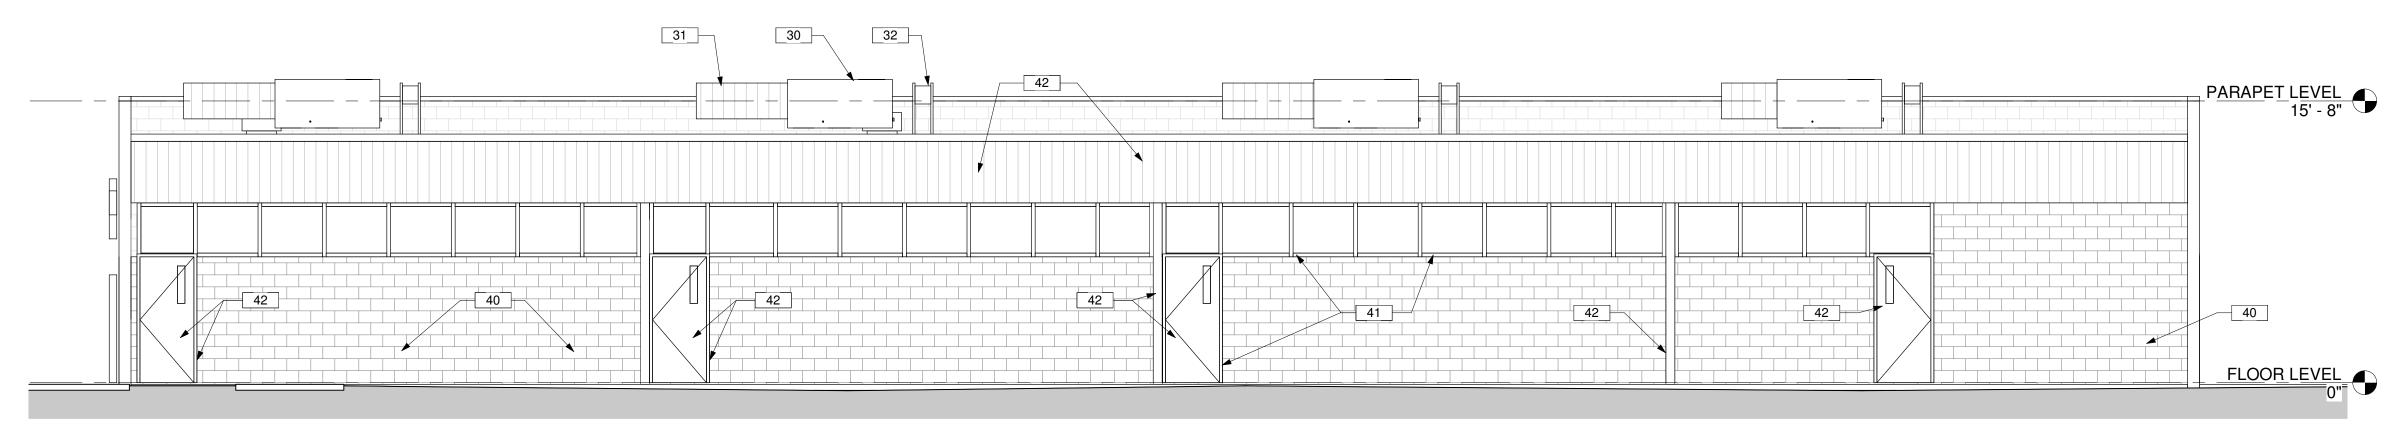


2 SOUTH SIDE NORTH BUILDING 3/16" = 1'-0"

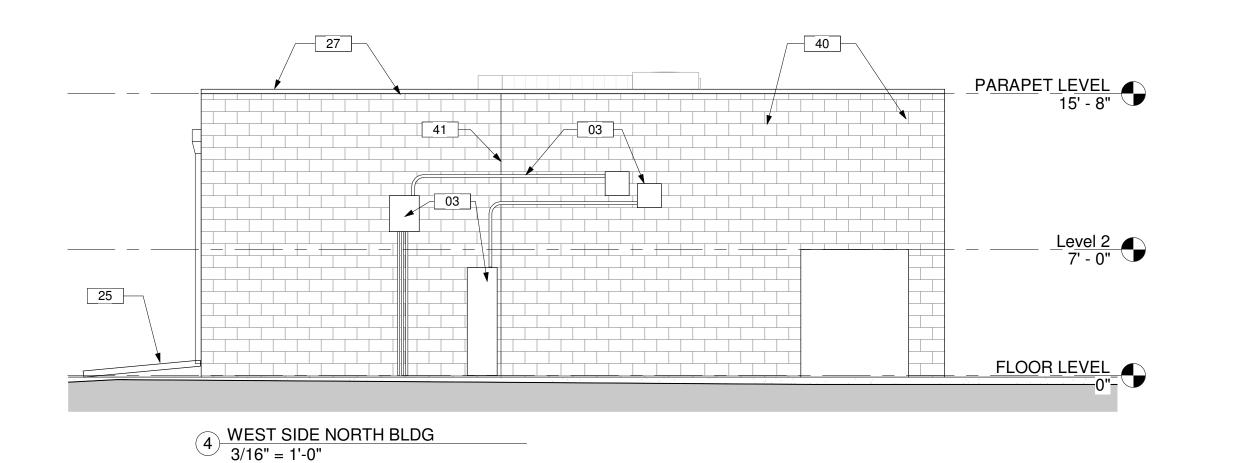

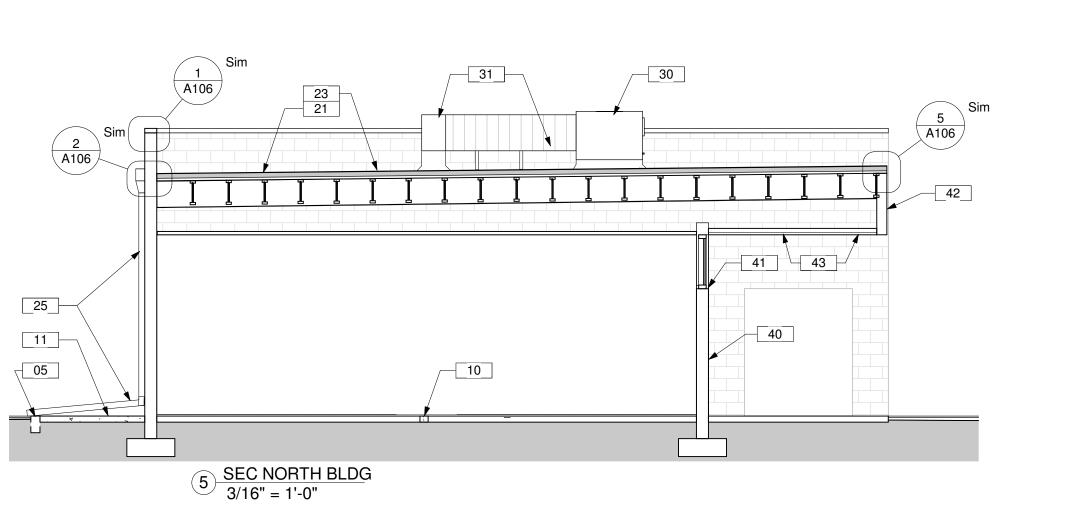

KEYNOTES

- 01 DISTRICT TO REMOVE, STORE AND REINSTALL FURNITURE FIXTURES AND EQUIPMENT WITHIN CLASSROOMS WHERE CONSTRUCTION WORK IS TO TAKE PLACE.
- 02 CONTRACTOR TO RESTORE ANY DISTURBED LANDSCAPE, GROUND COVER OR SIDEWALK MATERIALS TO ORIGINAL CONDITION.
- 03 EXISTING ELECTRICAL GEAR TO REMAIN UNDISTURBED. SEAL ALL PENETRATIONS THROUGH EXTERIOR MASONRY.
- 04 PATCH AND REPAIR GYP BOARD WALL, BASE AND FLOOR MATERIAL WHERE REMOVED OR DISTURBED FOR REPAIR OF CONCRETE FLOOR SLAB.
- 05 EXISTING CONCRETE CURB TO BE REMOVED.
- 10 PORTION OF EXISTING INTERIOR CONCRETE FLOOR SLAB TO BE REPAIRED, TYPICALLY AT CENTER OF CLASSROOM EAST TO WEST. REMOVE FLOOR TILE AND GRIND SMOOTH ANY VERTICAL DISPLACEMENT ONE SIDE OF CRACK TO THE OTHER. PATCH CRACK AND INSTALL NEW VINYL IN AREA OF REPAIRS. SEE STRUCTURAL PLAN FOR SPECIFICS ON SLAB.
- 11 INSTALL NEW 4" THICK 5' WIDE CONCRETE SIDEWALK ON COMPACTED ABC SLOPED TO THE NORTH 1/4" PER FOOT CROSS SLOPE.
- 12 LOCATIONS WHERE FOUNDATION SUPPORTS ARE TO BE INSTALLED FROM THE BUILDING EXTERIOR REQUIRE REGRADING OF DISTURBED EARTH OR GROUND COVER MATERIALS OR REPAIRING OF DAMAGED CONCRETE.
- 20 AT SOUTH BUILDING ROOF REMOVE TWO ROOF LAYERS, THE EXISTING TORCH DOWN LAYER OVER OSB, AND THE BUILT UP ROOF SYSTEM INCLUDING COVERBOARD AND RIGID INSULATION TO ROOF DECK.
- 21 AT NORTH BUILDING ROOF REMOVE BUILT UP ROOF SYSTEM TO THE DECK.
- 22 TYPICAL BOTH BUILDINGS REMOVE ALL BASE FLASHING, REGLETS, COUNTERFLASHINGS AND EDGE TRIMS. INSPECT DECK AND RELATED ITEMS AND REPAIR OR REPLACE WHERE DAMAGED OR DETERIORATED.
- 23 TYPICAL BOTH BUILDINGS INSTALL 4" OF NEW RIGID INSULATION, TAPERED CRICKETS TO SCUPPERS, WITH NEW COVER BOARD, NEW REGLETS AT ADJUSTED HEIGHTS, NEW SCUPPERS, NEW FLASHINGS AND COUNTERFLASHINGS. INSTALL NEW PVC ROOF MEMBRANE SYSTEM.
- 24 NEW WALKPAD MATERIAL AT EACH UNIT, TYPICAL. INSTALL ON FILTER SIDE OF UNIT.
- 25 PROVIDE NEW DOWNSPOUTS AND EXTEND APPROXIMATELY 10 FEET BEYOND EXTERIOR WALL TO DIVERT RAINWATER AWAY FROM BUILDING FOUNDATIONS.
- 26 REMOVE AND REPLACE EXISTING THROUGH WALL SCUPPERS, TYPICAL.
- 27 EXISTING NORTH BUILDING METAL COPING AND WOOD NAILER TO BE REMOVED AND REPLACED WITH NEW.
- 28 PROVIDE AND INSTALL NEW WOOD NAILER AND METAL COPING ON SOUTH BUILDING.
- 29 PROVIDE TAPERED INSULATION FOR CRICKET, SLOPE MIN. 1/4" PER FT TO SCUPPERS.
- 30 EXISTING MECHANICAL UNITS, VENTS, EXHAUST FANS, SUPPORTS, CURBS, ETC. ARE TO BE INSPECTED BY THE ROOF MANUFACTURER REPRESENTATIVE FOR COMPLIANCE WITH THEIR WARRANTY REQUIREMENTS. CURBS SHALL BE ADJUSTED AND SUPPORTS REPLACED IF NECESSARY TO ACHIEVE THE 20 YEAR MANUFACTURER'S WARRANTY.
- 31 EXISTING DUCTWORK ABOVE ROOF SHALL BE INSPECTED AND PATCHED WHERE NECESSARY TO INSURE WATERTIGHT SYSTEM.
- 32 EXISTING UTILITY LINES (GAS, WATER, OR ELEC CONDUITS AND DISCONNECTS) TO REMAIN, SUPPORT AS NECESSARY DURING REROOF WORK, REMOVE WOOD BLOCKING AND PROVIDE NEW RUBBER SUPPORT BLOCKS. INSPECT AND REPLACE ELECTRICAL WHIPS AND OR CONDENSATE LINES WHERE NECESSARY FOR SAFETY OR CODE COMPLIANCE.
- 40 EXTERIOR MASONRY WALLS TO REMAIN, TYPICAL. REPAIR CRACKS IN JOINTS AND MASONRY AFTER FOUNDATION WORK IS COMPLETED. CLEAN, BLOCKFILL, PRIME AND COAT ALL EXTERIOR BLOCK SURFACES.
- 41 REMOVE AND REPLACE ALL BUILDING SEALANTS
 INCLUDING CONSTRUCTION JOINTS, SEALANT AROUND
 DOORS AND WINDOWS, SEALANT AT ALL BUILDING
 PENETRATIONS.
- 42 CLEAN, PRIME AND PAINT ALL EXTERIOR METAL DOORS, HOLLOW METAL WINDOW AND DOOR FRAMES, METAL FASCIAS, VERTICAL METAL PANELS AND METAL TRIMS. ALUMINUM FRAMES TO BE CLEANED.
- 43 CLEAN, PRIME AND PAINT EXTERIOR GYP BD OR PLASTER.
- 44 CLEAN, REPAIR/PATCH, PRIME AND PAINT EXTERIOR SOFFIT.

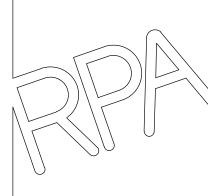

ROBERT POLCAR ARCHITECTS, INC (480) 675-9760 (602) 363-4096 SCOTTSDALE, ARIZONA

> DOUGLAS UNIFIED DISTRICT FARAS SCHOOL WEATHERIZATION 410 W FIR AVE, PIRTLEVILLE, AZ 85626

14997
ROBERT J.
POLCAR

02.08.21

Signed

EXPIRES 12/31/21

Revision Revision Date

Project number

020227105-9999-012BRG

Date

02.08.21

02.08.21
Drawn by
BP

Sheet Size ARCH D

Sheet Name

NORTH BUILDING

NORTH BUILDING

KS

A103

ROBERT POLCAR ARCHITECTS, INC (480) 675-9760 (602) 363-4096 SCOTTSDALE, ARIZONA







- 03 EXISTING ELECTRICAL GEAR TO REMAIN UNDISTURBED. SEAL ALL PENETRATIONS THROUGH EXTERIOR MASONRY.
- 04 PATCH AND REPAIR GYP BOARD WALL, BASE AND FLOOR MATERIAL WHERE REMOVED OR DISTURBED FOR REPAIR OF CONCRETE FLOOR SLAB.
- 05 EXISTING CONCRETE CURB TO BE REMOVED. 10 PORTION OF EXISTING INTERIOR CONCRETE FLOOR SLAB TO BE REPAIRED, TYPICALLY AT CENTER OF CLASSROOM EAST TO WEST. REMOVE FLOOR TILE AND GRIND SMOOTH ANY VERTICAL DISPLACEMENT ONE SIDE OF CRACK TO THE OTHER, PATCH CRACK AND INSTALL NEW VINYL IN AREA OF REPAIRS. SEE
- 11 INSTALL NEW 4" THICK 5' WIDE CONCRETE SIDEWALK ON COMPACTED ABC SLOPED TO THE NORTH 1/4" PER FOOT CROSS SLOPE.


STRUCTURAL PLAN FOR SPECIFICS ON SLAB.


- 12 LOCATIONS WHERE FOUNDATION SUPPORTS ARE TO BE INSTALLED FROM THE BUILDING EXTERIOR REQUIRE REGRADING OF DISTURBED EARTH OR GROUND COVER MATERIALS OR REPAIRING OF DAMAGED CONCRETE.
- 20 AT SOUTH BUILDING ROOF REMOVE TWO ROOF LAYERS, THE EXISTING TORCH DOWN LAYER OVER OSB, AND THE BUILT UP ROOF SYSTEM INCLUDING COVERBOARD AND RIGID INSULATION TO ROOF DECK.
- 21 AT NORTH BUILDING ROOF REMOVE BUILT UP ROOF — SYSTEM TO THE DECK.
- 22 TYPICAL BOTH BUILDINGS REMOVE ALL BASE FLASHING, REGLETS, COUNTERFLASHINGS AND EDGE TRIMS. INSPECT DECK AND RELATED ITEMS AND REPAIR OR REPLACE WHERE DAMAGED OR DETERIORATED.
- 23 TYPICAL BOTH BUILDINGS INSTALL 4" OF NEW RIGID INSULATION, TAPERED CRICKETS TO SCUPPERS, WITH NEW COVER BOARD, NEW REGLETS AT ADJUSTED HEIGHTS, NEW SCUPPERS, NEW FLASHINGS AND COUNTERFLASHINGS. INSTALL NEW PVC ROOF MEMBRANE SYSTEM.
- 24 NEW WALKPAD MATERIAL AT EACH UNIT, TYPICAL. INSTALL ON FILTER SIDE OF UNIT.
- 25 PROVIDE NEW DOWNSPOUTS AND EXTEND APPROXIMATELY 10 FEET BEYOND EXTERIOR WALL TO DIVERT RAINWATER AWAY FROM BUILDING FOUNDATIONS.
- 26 REMOVE AND REPLACE EXISTING THROUGH WALL SCUPPERS, TYPICAL.
- 27 EXISTING NORTH BUILDING METAL COPING AND WOOD NAILER TO BE REMOVED AND REPLACED WITH NEW.
- 28 PROVIDE AND INSTALL NEW WOOD NAILER AND METAL COPING ON SOUTH BUILDING.
- 29 PROVIDE TAPERED INSULATION FOR CRICKET, SLOPE MIN. 1/4" PER FT TO SCUPPERS.
- 30 EXISTING MECHANICAL UNITS, VENTS, EXHAUST FANS, SUPPORTS, CURBS, ETC. ARE TO BE INSPECTED BY THE ROOF MANUFACTURER REPRESENTATIVE FOR COMPLIANCE WITH THEIR WARRANTY REQUIREMENTS. CURBS SHALL BE ADJUSTED AND SUPPORTS REPLACED IF NECESSARY TO ACHIEVE THE 20 YEAR MANUFACTURER'S WARRANTY.
- 31 EXISTING DUCTWORK ABOVE ROOF SHALL BE INSPECTED AND PATCHED WHERE NECESSARY TO INSURE WATERTIGHT SYSTEM.
- 32 EXISTING UTILITY LINES (GAS, WATER, OR ELEC CONDUITS AND DISCONNECTS) TO REMAIN, SUPPORT AS NECESSARY DURING REROOF WORK, REMOVE WOOD BLOCKING AND PROVIDE NEW RUBBER SUPPORT BLOCKS. INSPECT AND REPLACE ELECTRICAL WHIPS AND OR CONDENSATE LINES WHERE NECESSARY FOR SAFETY OR CODE COMPLIANCE.
- 40 EXTERIOR MASONRY WALLS TO REMAIN, TYPICAL REPAIR CRACKS IN JOINTS AND MASONRY AFTER FOUNDATION WORK IS COMPLETED. CLEAN, BLOCKFILL, PRIME AND COAT ALL EXTERIOR BLOCK SURFACES.
- 41 REMOVE AND REPLACE ALL BUILDING SEALANTS INCLUDING CONSTRUCTION JOINTS, SEALANT AROUND DOORS AND WINDOWS, SEALANT AT ALL BUILDING PENETRATIONS.
- 42 CLEAN, PRIME AND PAINT ALL EXTERIOR METAL DOORS, HOLLOW METAL WINDOW AND DOOR FRAMES, METAL FASCIAS, VERTICAL METAL PANELS AND METAL TRIMS. ALUMINUM FRAMES TO BE CLEANED.
- 43 CLEAN, PRIME AND PAINT EXTERIOR GYP BD OR PLASTER.
- 44 CLEAN, REPAIR/PATCH, PRIME AND PAINT EXTERIOR SOFFIT.

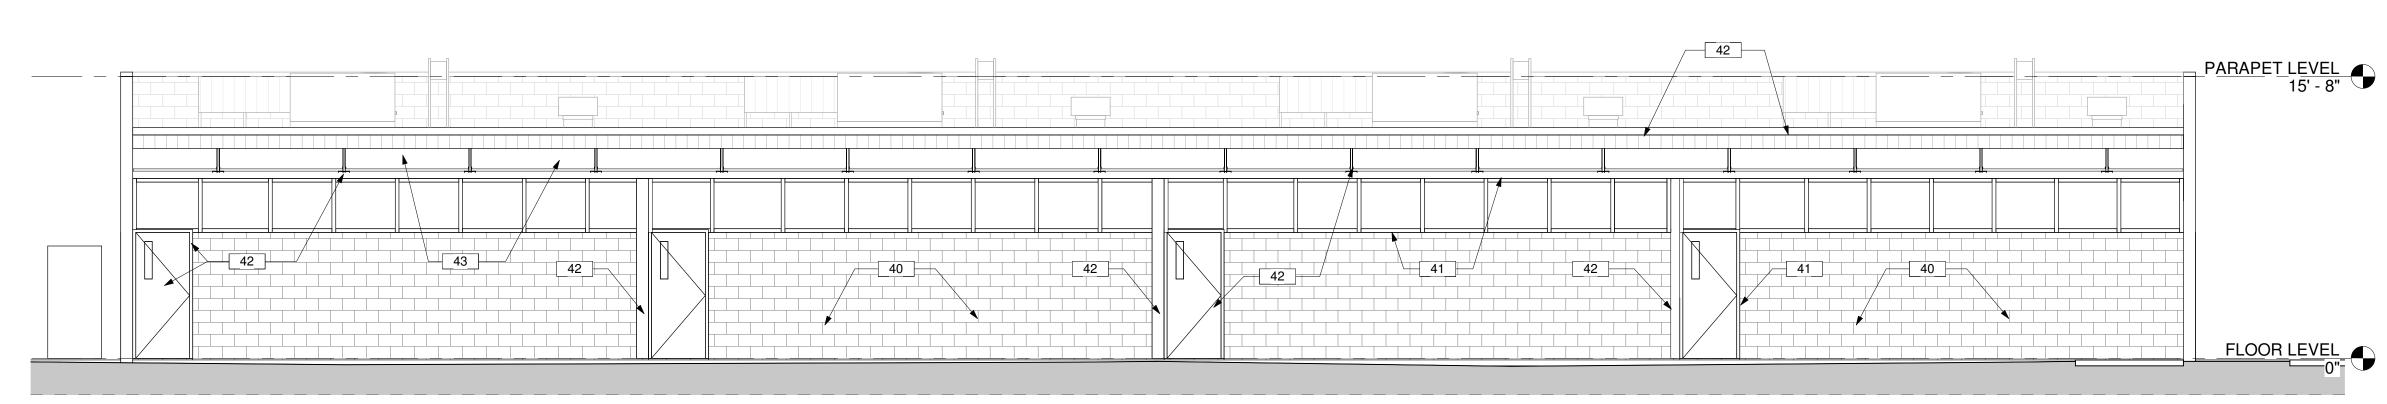


1 NORTH SIDE SOUTH BLDG 3/16" = 1'-0"

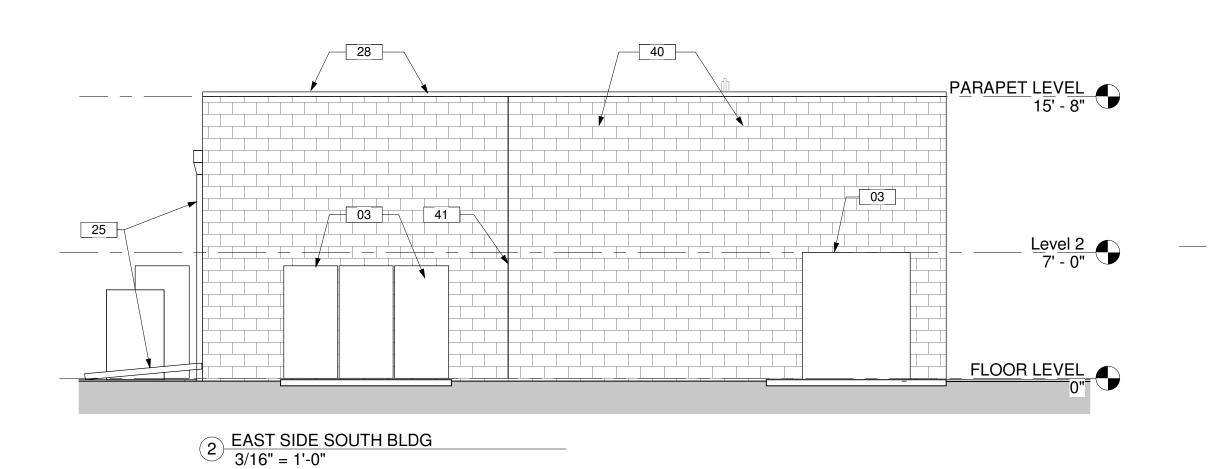

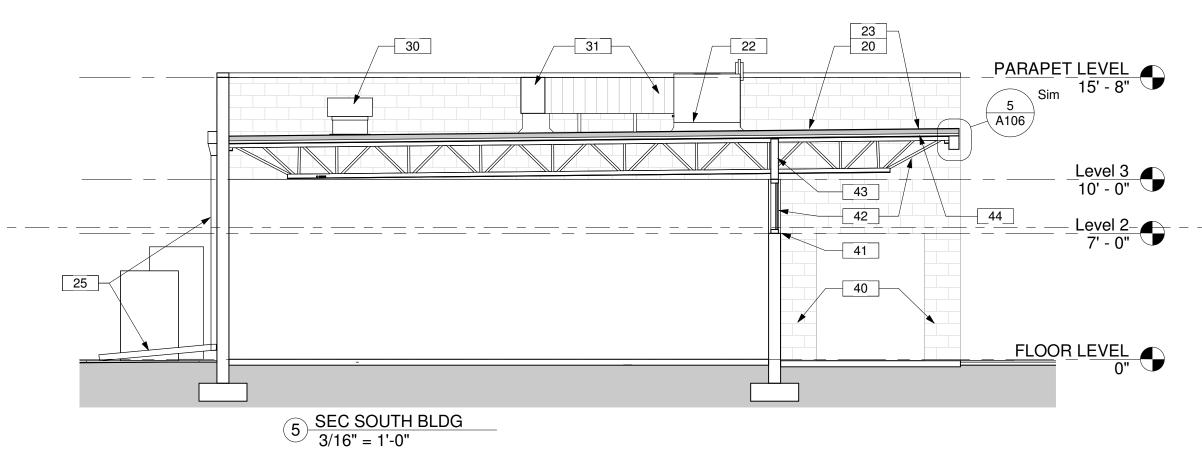

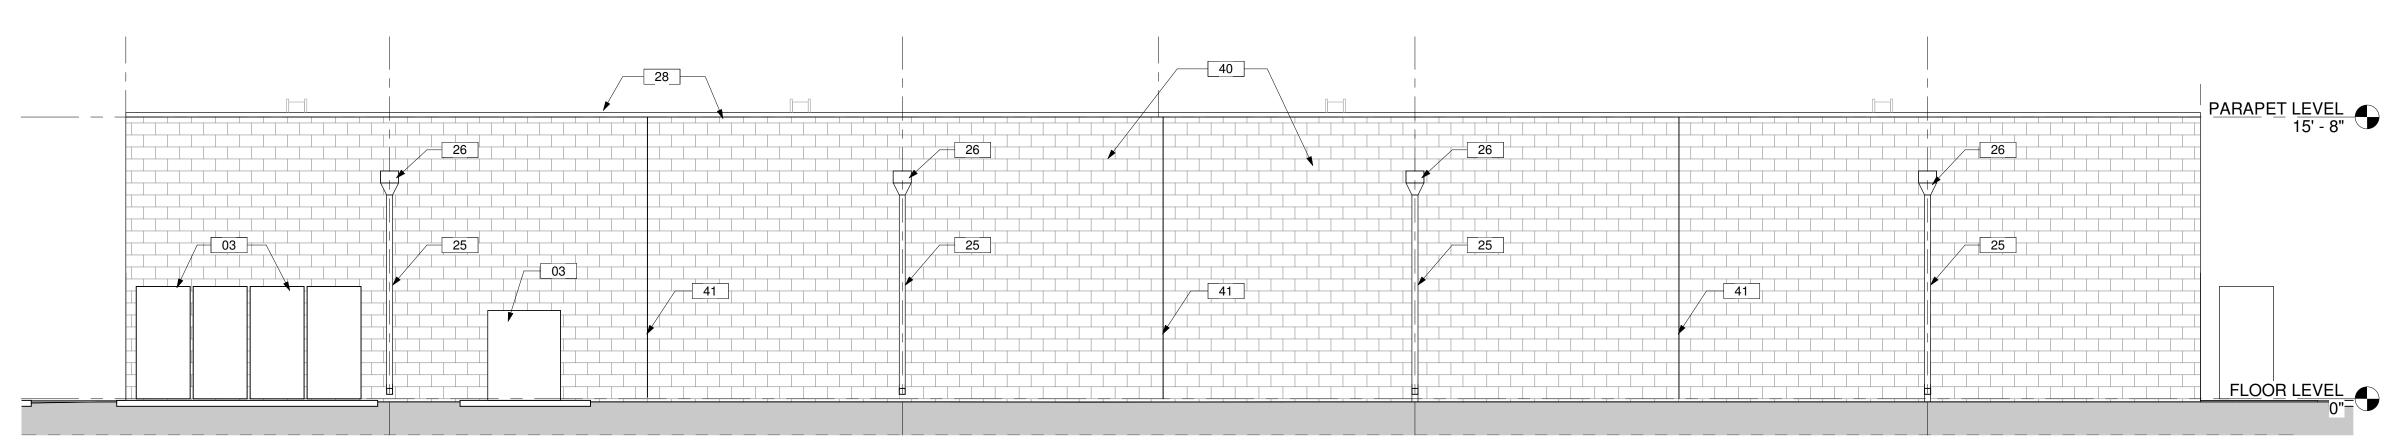

3 SOUTH SIDE SOUTH BLDG
3/16" = 1'-0"

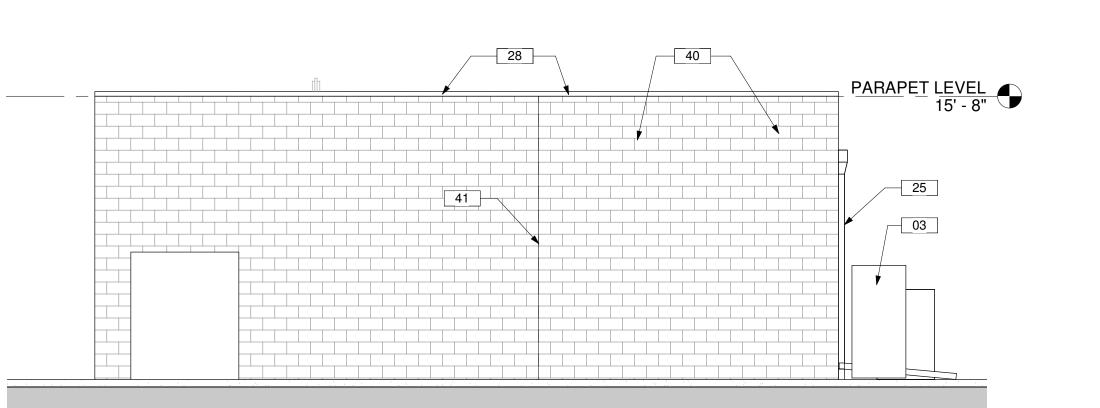








WEST SIDE SOUTH BLDG
3/16" = 1'-0"

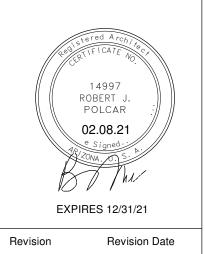


DC FARA 410 W F

Project number 020227105-9999-012BRG

02.08.21 Drawn by

Checked by Sheet Size ARCH D Sheet Name

SOUTH BUILDING

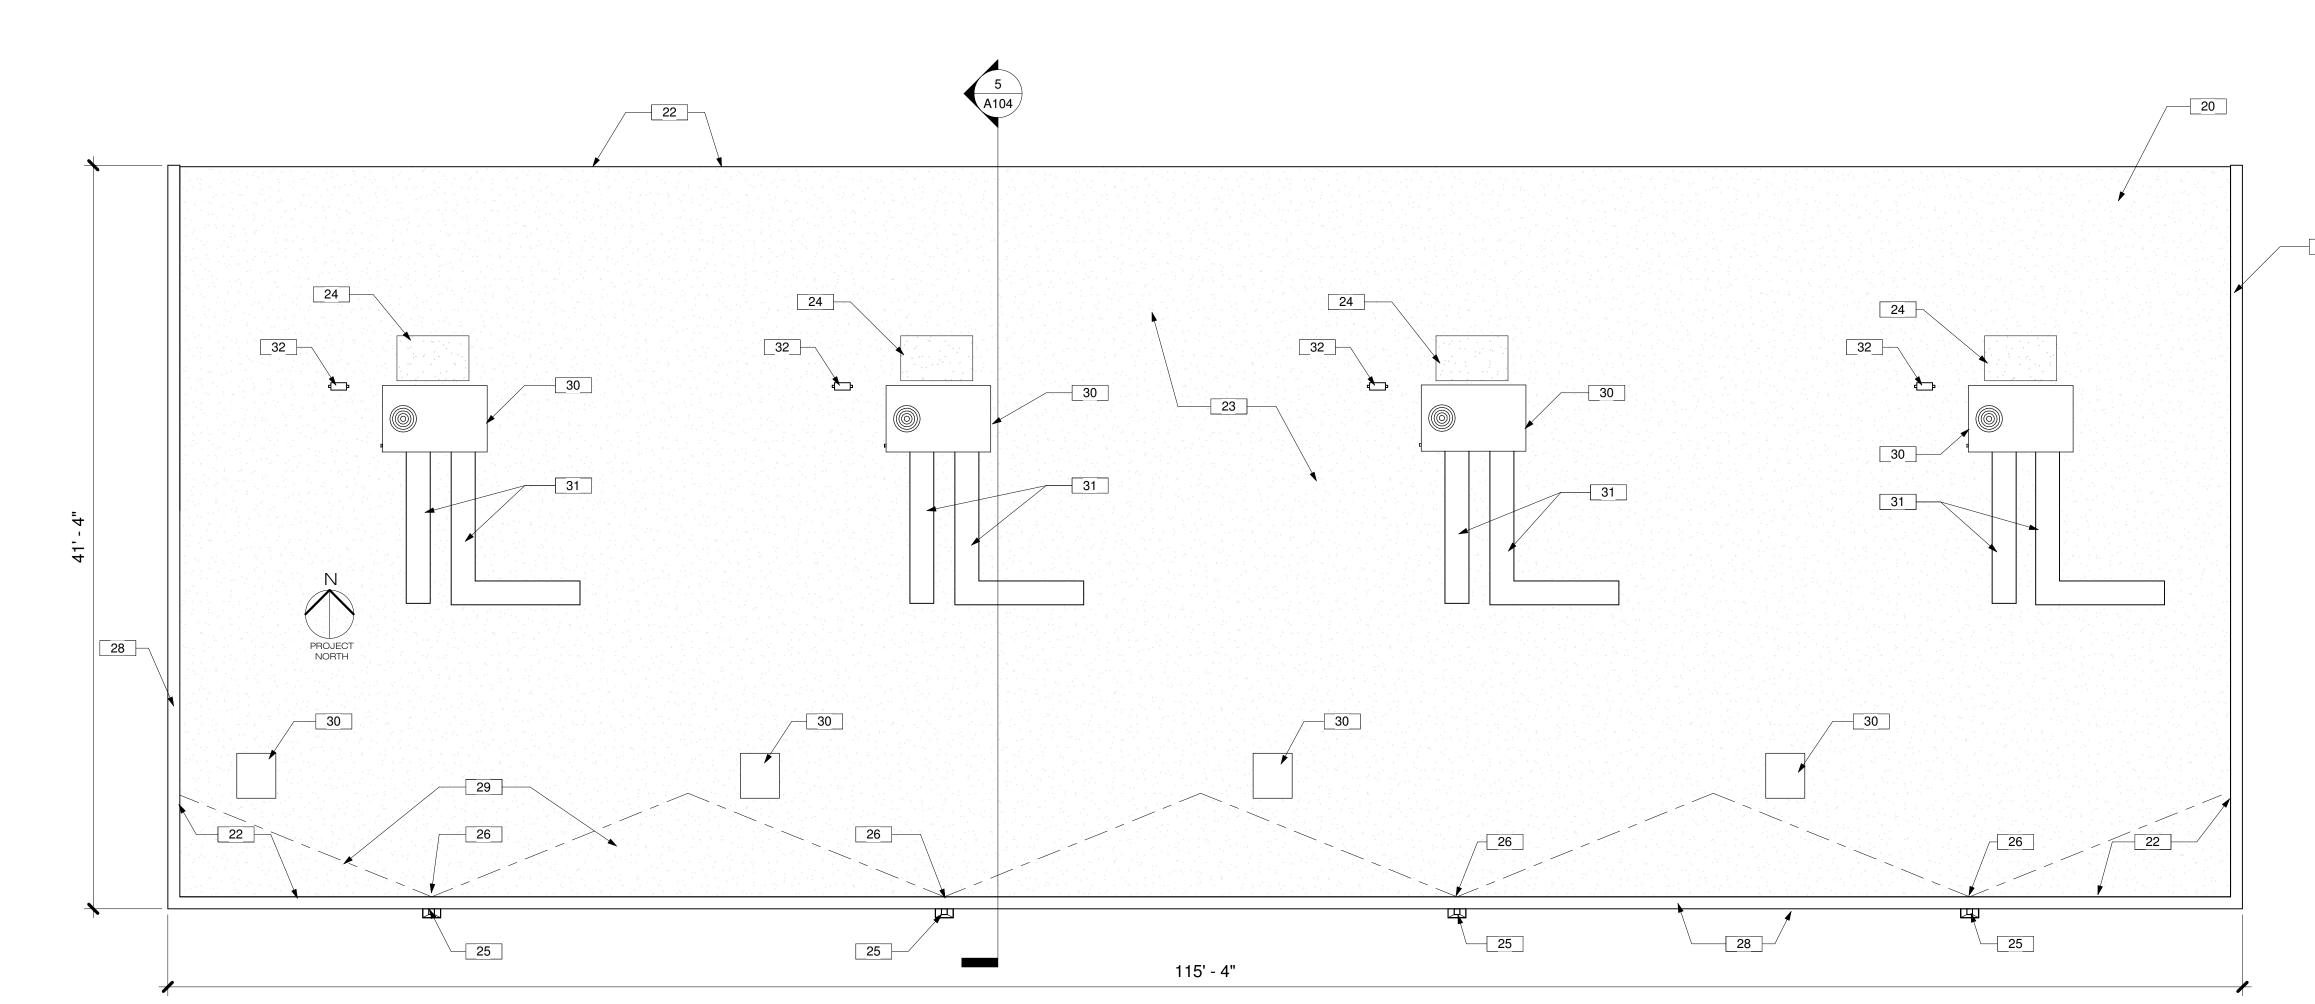


KEYNOTES


- 01 DISTRICT TO REMOVE, STORE AND REINSTALL FURNITURE FIXTURES AND EQUIPMENT WITHIN CLASSROOMS WHERE CONSTRUCTION WORK IS TO TAKE PLACE.
- 02 CONTRACTOR TO RESTORE ANY DISTURBED LANDSCAPE, GROUND COVER OR SIDEWALK MATERIALS TO ORIGINAL CONDITION.
- 03 EXISTING ELECTRICAL GEAR TO REMAIN UNDISTURBED. SEAL ALL PENETRATIONS THROUGH EXTERIOR MASONRY.
- 04 PATCH AND REPAIR GYP BOARD WALL, BASE AND FLOOR MATERIAL WHERE REMOVED OR DISTURBED FOR REPAIR OF CONCRETE FLOOR SLAB.
- 05 EXISTING CONCRETE CURB TO BE REMOVED.
- 10 PORTION OF EXISTING INTERIOR CONCRETE FLOOR SLAB TO BE REPAIRED, TYPICALLY AT CENTER OF CLASSROOM EAST TO WEST. REMOVE FLOOR TILE AND GRIND SMOOTH ANY VERTICAL DISPLACEMENT ONE SIDE OF CRACK TO THE OTHER. PATCH CRACK AND INSTALL NEW VINYL IN AREA OF REPAIRS. SEE STRUCTURAL PLAN FOR SPECIFICS ON SLAB.
- 11 INSTALL NEW 4" THICK 5' WIDE CONCRETE SIDEWALK ON COMPACTED ABC SLOPED TO THE NORTH 1/4" PER FOOT CROSS SLOPE.
- 12 LOCATIONS WHERE FOUNDATION SUPPORTS ARE TO BE INSTALLED FROM THE BUILDING EXTERIOR REQUIRE REGRADING OF DISTURBED EARTH OR GROUND COVER MATERIALS OR REPAIRING OF DAMAGED CONCRETE.
- 20 AT SOUTH BUILDING ROOF REMOVE TWO ROOF LAYERS, THE EXISTING TORCH DOWN LAYER OVER OSB, AND THE BUILT UP ROOF SYSTEM INCLUDING COVERBOARD AND RIGID INSULATION TO ROOF DECK.
- 21 AT NORTH BUILDING ROOF REMOVE BUILT UP ROOF SYSTEM TO THE DECK.
- 22 TYPICAL BOTH BUILDINGS REMOVE ALL BASE FLASHING, REGLETS, COUNTERFLASHINGS AND EDGE TRIMS. INSPECT DECK AND RELATED ITEMS AND REPAIR OR REPLACE WHERE DAMAGED OR DETERIORATED.
- 23 TYPICAL BOTH BUILDINGS INSTALL 4" OF NEW RIGID INSULATION, TAPERED CRICKETS TO SCUPPERS, WITH NEW COVER BOARD, NEW REGLETS AT ADJUSTED HEIGHTS, NEW SCUPPERS, NEW FLASHINGS AND COUNTERFLASHINGS. INSTALL NEW PVC ROOF MEMBRANE SYSTEM.
- 24 NEW WALKPAD MATERIAL AT EACH UNIT, TYPICAL. INSTALL ON FILTER SIDE OF UNIT.
- 25 PROVIDE NEW DOWNSPOUTS AND EXTEND APPROXIMATELY 10 FEET BEYOND EXTERIOR WALL TO DIVERT RAINWATER AWAY FROM BUILDING FOUNDATIONS.
- 26 REMOVE AND REPLACE EXISTING THROUGH WALL SCUPPERS, TYPICAL.
- 27 EXISTING NORTH BUILDING METAL COPING AND WOOD
- NAILER TO BE REMOVED AND REPLACED WITH NEW.

 28 PROVIDE AND INSTALL NEW WOOD NAILER AND METAL COPING ON SOUTH BUILDING.
- 29 PROVIDE TAPERED INSULATION FOR CRICKET, SLOPE MIN. 1/4" PER FT TO SCUPPERS.
- 30 EXISTING MECHANICAL UNITS, VENTS, EXHAUST FANS, SUPPORTS, CURBS, ETC. ARE TO BE INSPECTED BY THE ROOF MANUFACTURER REPRESENTATIVE FOR COMPLIANCE WITH THEIR WARRANTY REQUIREMENTS. CURBS SHALL BE ADJUSTED AND SUPPORTS REPLACED IF NECESSARY TO ACHIEVE THE 20 YEAR
- 31 EXISTING DUCTWORK ABOVE ROOF SHALL BE INSPECTED AND PATCHED WHERE NECESSARY TO INSURE WATERTIGHT SYSTEM.

MANUFACTURER'S WARRANTY.

- 32 EXISTING UTILITY LINES (GAS, WATER, OR ELEC CONDUITS AND DISCONNECTS) TO REMAIN, SUPPORT AS NECESSARY DURING REROOF WORK, REMOVE WOOD BLOCKING AND PROVIDE NEW RUBBER SUPPORT BLOCKS. INSPECT AND REPLACE ELECTRICAL WHIPS AND OR CONDENSATE LINES WHERE NECESSARY FOR SAFETY OR CODE COMPLIANCE.
- 40 EXTERIOR MASONRY WALLS TO REMAIN, TYPICAL. REPAIR CRACKS IN JOINTS AND MASONRY AFTER FOUNDATION WORK IS COMPLETED. CLEAN, BLOCKFILL, PRIME AND COAT ALL EXTERIOR BLOCK SURFACES.
- 41 REMOVE AND REPLACE ALL BUILDING SEALANTS INCLUDING CONSTRUCTION JOINTS, SEALANT AROUND DOORS AND WINDOWS, SEALANT AT ALL BUILDING PENETRATIONS.
- 42 CLEAN, PRIME AND PAINT ALL EXTERIOR METAL DOORS, HOLLOW METAL WINDOW AND DOOR FRAMES, METAL FASCIAS, VERTICAL METAL PANELS AND METAL TRIMS. ALUMINUM FRAMES TO BE CLEANED.
- 43 CLEAN, PRIME AND PAINT EXTERIOR GYP BD OR PLASTER.
- 44 CLEAN, REPAIR/PATCH, PRIME AND PAINT EXTERIOR SOFFIT.

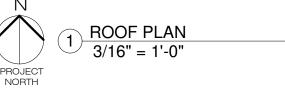

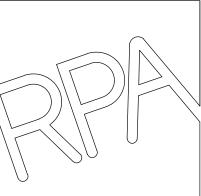

ROBERT POLCAR ARCHITECTS, INC (480) 675-9760 (602) 363-4096 SCOTTSDALE, ARIZONA

> DOUGLAS UNIFIED DISTRICT FARAS SCHOOL WEATHERIZATION 410 W FIR AVE, PIRTLEVILLE, AZ 85626



evision Revision Date

Revision Revision Date

Project number

020227105-9999-012BRG

Date

02.08.21

Drawn by

BF


Checked by


Sheet Size ARCH D


Sheet Name

ROOF PLANS

105

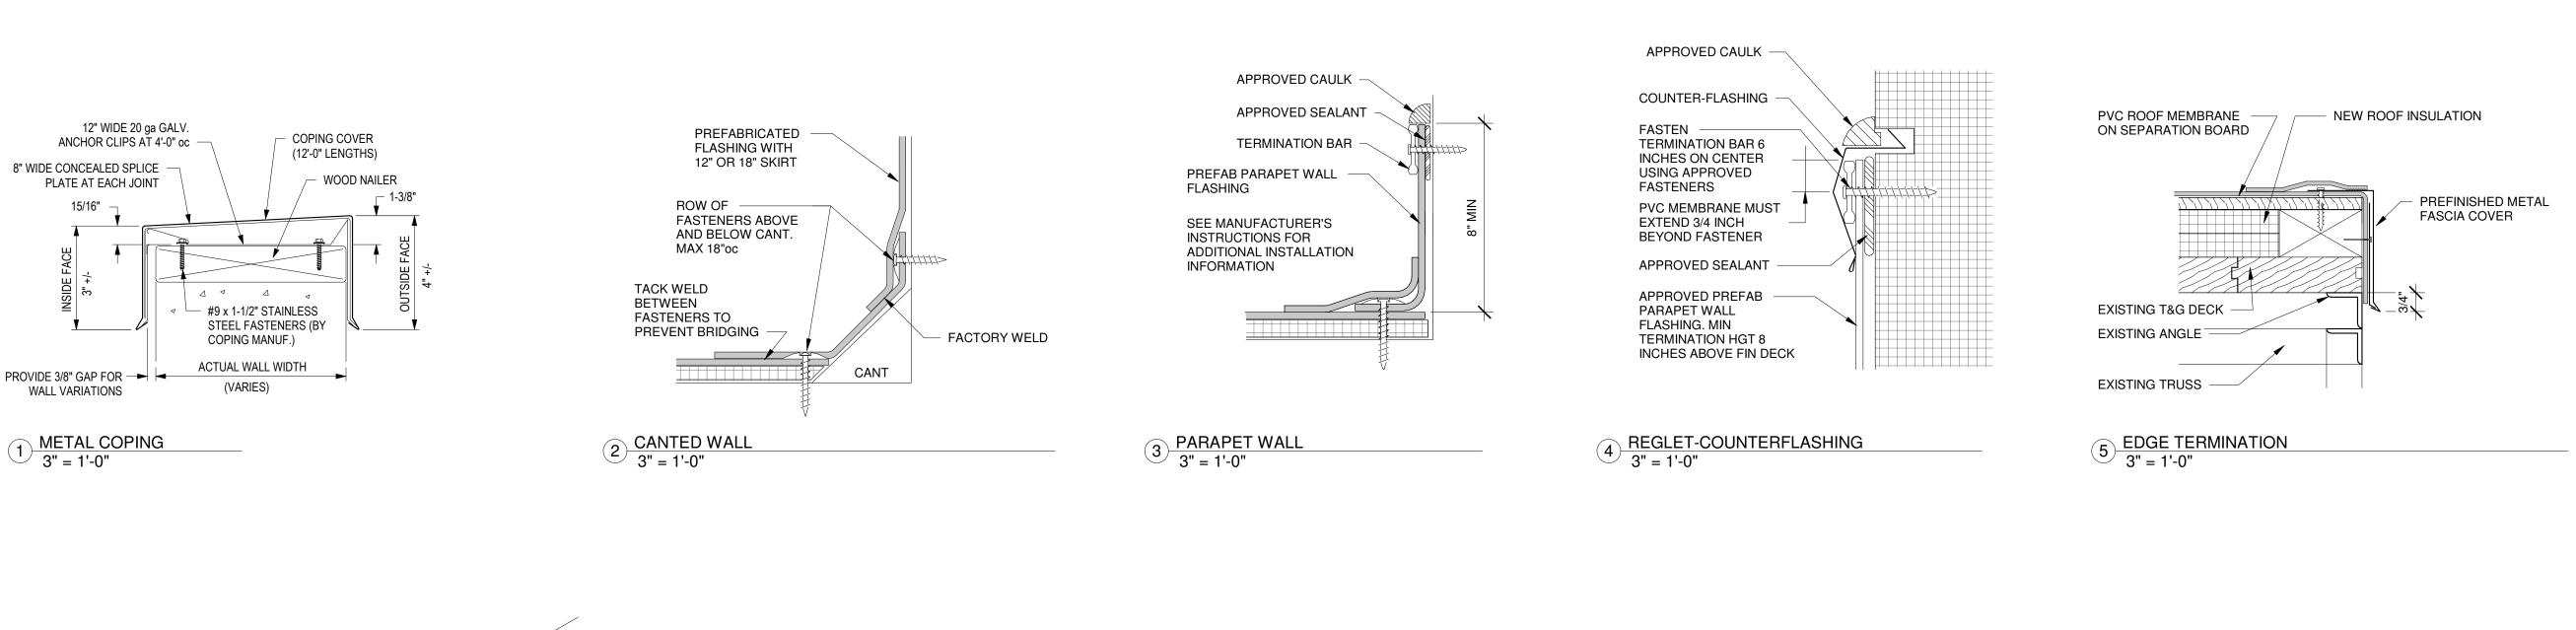

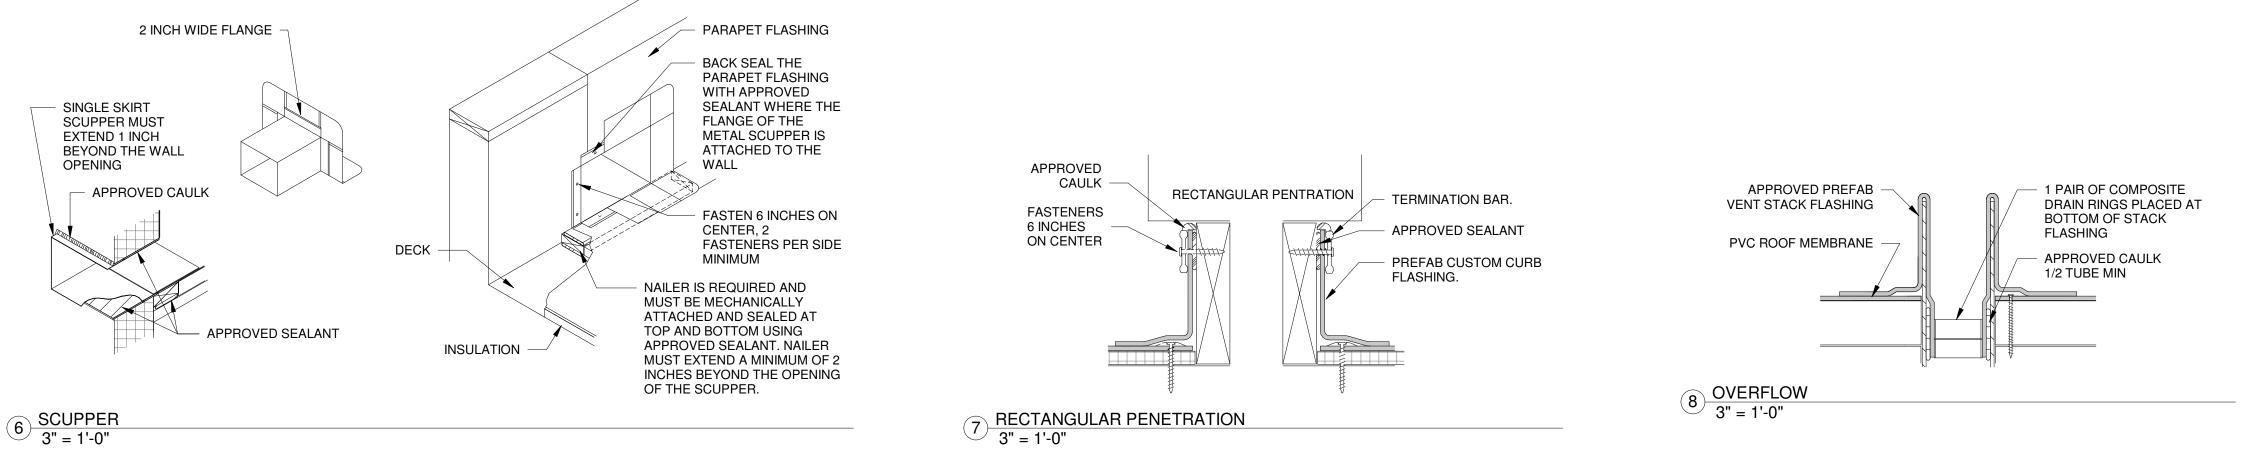

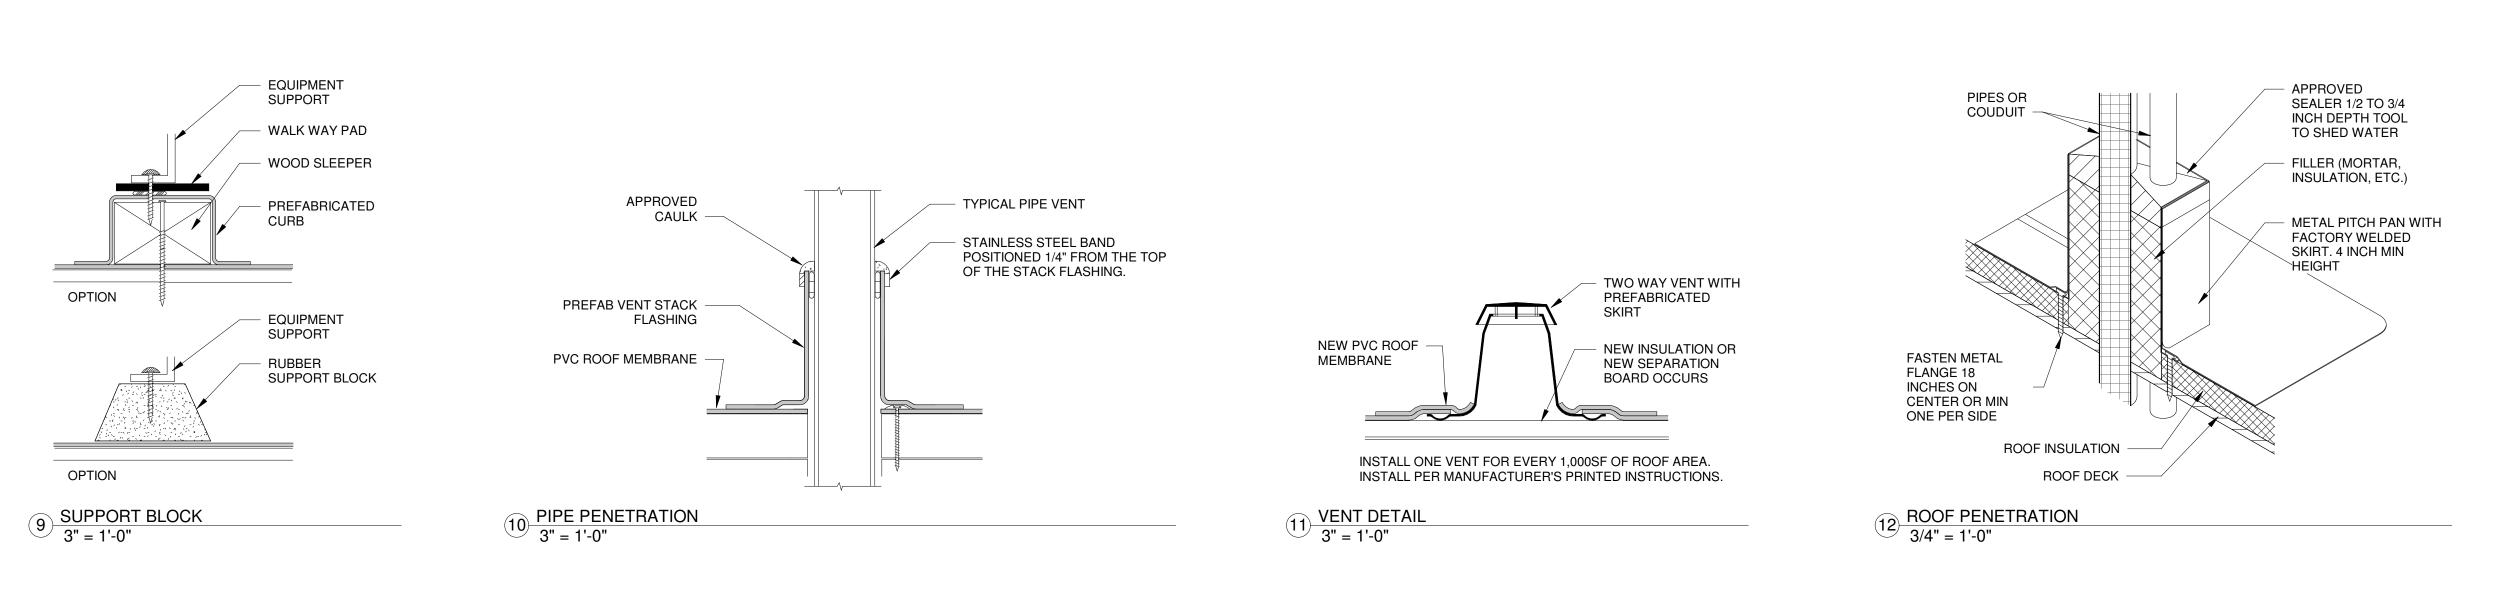



ROBERT POLCAR ARCHITECTS, INC (480) 675-9760 (602) 363-4096 SCOTTSDALE, ARIZONA



Revision Revision Date

Project number

020227105-9999-012BRG


02.08.21 Drawn by

Sheet Size ARCH D MISC DETAILS


Checked by

STRUCTURAL NOTES:

- 1. DESIGN CRITERIA:
- A. ALL CONSTRUCTION SHALL CONFORM TO THE 2012 EDITION OF THE INTERNATIONAL BUILDING CODE.
- B. EXISTING ROOF:
- ROOF LIVE LOAD = 20 PSF (REDUCIBLE) ROOF DEAD LOAD = 16 PSF
- 2. DETAILS AND NOTES ON DRAWINGS SHALL TAKE PRECEDENCE OVER STRUCTURAL NOTES AND TYPICAL DETAILS. WHERE NO SPECIFIC DETAILS ARE SHOWN, CONSTRUCTION SHALL CONFORM TO SIMILAR WORK ON THE PROJECT.
- 3. DO NOT SCALE DRAWINGS. VERIFY ALL DIMENSIONS WITH
- EXISTING CONDITIONS PRIOR TO START OF CONSTRUCTION.
 4. DETAILS MARKED "TYPICAL" MAY OR MAY NOT BE CUT ON PLANS, BUT
- SHALL APPLY UNLESS NOTED OTHERWISE.
- 5. THE CONTRACTOR SHALL TAKE ALL NECESSARY MEASURES TO PROTECT THE STRUCTURE DURING CONSTRUCTION, INCLUDING, BUT NOT LIMITED TO, SHORING, BRACING, ETC. THE CONTRACTOR SHALL BE RESPONSIBLE FOR THE DESIGN AND IMPLEMENTATION OF ALL SHORING, BRACING, AND SCAFFOLDING. OBSERVATION VISITS OR SPECIAL INSPECTION TO THE SITE BY THE STRUCTURAL ENGINEER SHALL NOT INCLUDE INSPECTION OF THE ABOVE ITEMS. THE STRUCTURAL ENGINEER WILL NOT BE RESPONSIBLE FOR THE CONTRACTOR'S MEANS, METHODS, TECHNIQUES, SEQUENCES OR PROCEDURES OF CONSTRUCTION SITE SAFETY, OR THE SAFETY PRECAUTIONS AND PROGRAMS.
- 6. CONSTRUCTION MATERIALS SHALL BE SPREAD OUT IF PLACED ON FRAMED ROOF OR FLOORS. THE LOAD SHALL NOT EXCEED THE DESIGN LIVE LOAD PER SQUARE FOOT.
- 7. THE CONTRACT STRUCTURAL DRAWINGS REPRESENT THE FINISHED STRUCTURE. THEY DO NOT INDICATE THE MEANS OR METHOD OF CONSTRUCTION.
- 8. ALL CONSTRUCTION SHALL COMPLY WITH RECOMMENDATIONS OF THE GEOTECHNICAL REPORT #G24634, BY RICKER, ATKINSON, McBEE, MORMAN AND ASSOCIATES INC. DATED MARCH 15, 2018.
- 9. HELICAL PIERS SHALL BE DESIGNED BY A CIVIL OR STRUCTURAL ENGINEER REGISTERED IN THE STATE WHERE THE PROJECT IS LOCATED. THE DESIGN LOADS ARE STATED ON THE DRAWINGS. SHOP DRAWINGS AND CALCULATIONS SHALL BE STAMPED BY A CIVIL OR STRUCTURAL ENGINEER REGISTERED IN THE STATE AND SHALL BE SUBMITTED TO THE STRUCTURAL ENGINEER FOR REVIEW PRIOR TO FABRICATION.
- 10. MATERIALS SPECIFICATIONS:
- HELICAL PIERS DESIGNED FOR AN ALLOWABLE VERTICAL LOAD OF 25,000 LBS/PIER.
- 11. SPECIAL INSPECTIONS SHALL BE PERFORMED BY BRODERICK ENGINEERING, LLC OR A QUALIFIED INSPECTOR AS APPROVED BY THE BUILDING OFFICIAL. THE CONTRACTOR SHALL BE RESPONSIBLE FOR PROVIDING A MINIMUM OF 24 HOURS NOTICE TO THE SPECIAL INSPECTOR AND THE TESTING LABORATORY PRIOR TO BEGINNING ANY WORK FOR WHICH SPECIAL INSPECTION OR TESTING IS REQUIRED. THE SPECIAL INSPECTOR SHALL OBSERVE THE WORK ASSIGNED FOR CONFORMANCE WITH THE APPROVED DESIGN DRAWINGS AND SPECIFICATIONS. THE SPECIAL INSPECTOR SHALL FURNISH INSPECTION REPORTS TO THE BUILDING OFFICIAL AND TO THE ENGINEER OR ARCHITECT OF RECORD. ALL DISCREPANCIES SHALL BE BROUGHT TO THE IMMEDIATE ATTENTION OF THE CONTRACTOR FOR CORRECTION, THEN, IF UNCORRECTED, TO THE ENGINEER OR ARCHITECT OF RECORD AND THE BUILDING OFFICIAL. SPECIAL INSPECTION IS REQUIRED DURING THE FOLLOWING OPERATIONS PER IBC CHAPTER 17:
 - A. HELICAL PIERS: DURING INSTALLATION OF ALL HELICAL PIERS TO ENSURE THAT EMBEDMENT AND TORQUE REQUIREMENTS HAVE BEEN MET CONTINUOUS.

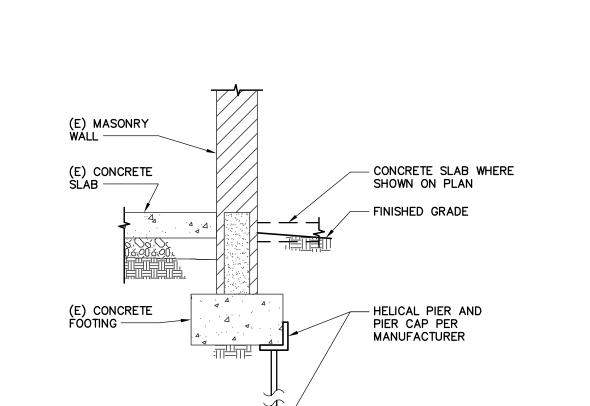

NEW HELICAL PIER AT EXISTING CONCRETE FOOTING (10

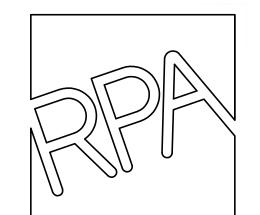

ROBERT POLCAR ARCHITECTS, INC (480) 675-9760 (602) 363-4096 SCOTTSDALE, ARIZONA

> DOUGLAS UNIFIED DISTRICT FARAS SCHOOL WEATHERIZATION 410 W FIR AVE, PIRTLEVILLE, AZ 8562



Revision Revision Date

Project number 020227105-9999-012BRG

09/25/18
Drawn by

JG

Checked by

RODERICK

LC.

MESA, AZ 85212

PH 480-926-6333

SUITE 124

MINEERING

B.E. JOB NO. 18174

BRODERICK ENGINEERING LLC. 6859 E. REMBRANDT AVE, 3275 W. INA RD.

FAX 480-926-3999 FAX 520-887-9486

SUITE 211

Tucson, AZ 85741

PH 520-887-9416

Sheet Size ARCH D 24"x36"

Structural Notes and Details

s1.0



DOUGLAS UNIFIED DISTRICT RAS SCHOOL WEATHERIZATION W FIR AVE, PIRTLEVILLE, AZ 85626

FOUNDATION PLAN NOTES

- INDICATES EXISTING MASONRY WALL AND ASSOCIATED CONCRETE FOOTING TO REMAIN TYPICAL.
- (2) EXISTING CONCRETE SLAB TO REMAIN TYPICAL.
- NEW HELICAL PIER DESIGNED FOR AN ALLOWABLE VERTICAL LOAD OF 25,000 LBS/PIER ATTACH TO EXISTING WALL FOOTING PER MANUFACTURER.
- USE NEW HELICAL PIER TO JACK UP EXISTING FOOTING AND WALL ASSEMBLY TO A LEVEL CONDITION.
- 5 EXISTING STEEL COLUMN AND ASSOCIATED CONCRETE FOOTING TO REMAIN.
- 6 FILL IN EXISTING CRACK VOIDS IN MASONRY WALL ASSEMBLY ABOVE WITH EPOXY DURING THE JACKING PROCESS OR AFTER JACKING IS COMPLETE DO NOT LET EPOXY CURE PRIOR TO COMPLETION OF THE JACKING PROCESS (PRIOR TO TIGHTENING UP EXISTING WALL CRACKS).
- 7 SLOPE FINISHED GRADE AWAY FROM EXISTING FOUNDATION PERIMETER AND/OR NEW CONCRETE SIDEWALK FOR 5'-0" MINIMUM TOWARDS POSITIVE DRAINAGE TO ELIMINATE PONDING WITHIN 10'-0" OF EXISTING FOUNDATION TYPICAL.
- (8) NEW CONCRETE SIDEWALK PER ARCHITECTURAL DRAWINGS.
- PREPAIR EXISTING SLAB CRACKS AND MONITOR AS REQUIRED PER GEOTECHNICAL REPORT AND ARCHITECTURAL DRAWINGS TYPICAL.
- MONITOR EXISTING WALL CRACKS AS REQUIRED PER GEOTECHNICAL REPORT AND ARCHITECTURAL DRAWINGS TYPICAL.

49332
RYAN MITCHELL
WENDT

SONED 1015

EXPIRES 3/31/2021

020227105-9999-012BRG

Revision Date

NOTE:
EVERY EFFORT HAS BEEN MADE TO DETERMINE
AS-BUILT CONDITIONS DURING DEVELOPMENT OF
CONSTRUCTION DOCUMENTS. PRIOR TO
CONSTRUCTION THE CONTRACTOR SHALL VERIFY
AS-BUILT CONDITIONS AND NOTIFY THE ENGINEER
OF RECORD IF IT IS DETERMINED THAT THE ACTUAL
CONDITIONS VARY FROM WHAT IS NOTED AND
REFERENCED ON THESE DRAWINGS.

RODERICK

BRODERICK ENGINEERING LLC.
6859 E. REMBRANDT AVE, 3275 W. INA RD.
SUITE 124 SUITE 211
MESA, AZ 85212 TUCSON, AZ 85741
PH 480-926-6333 PH 520-887-9416
FAX 480-926-3999 FAX 520-887-9486
B.E. JOB NO. 18174

Date

UNINGS.

09/25/18

Drawn by

JG

Checked by

RMW

Sheet Size ARCH D 24"x36"

s2.0

Foundation Plan

